



FORM 2A

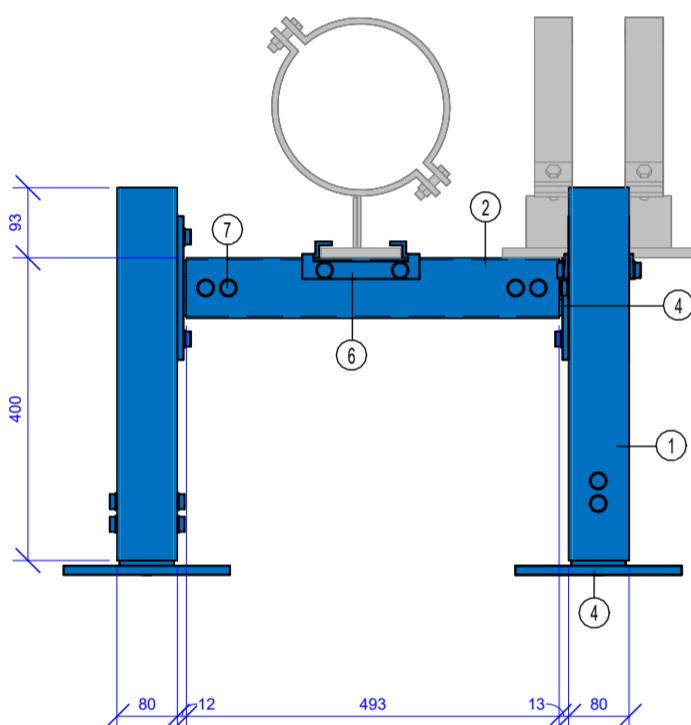

1 | Gantry Support 2.1.1 - Section A


SCALE: 1:10

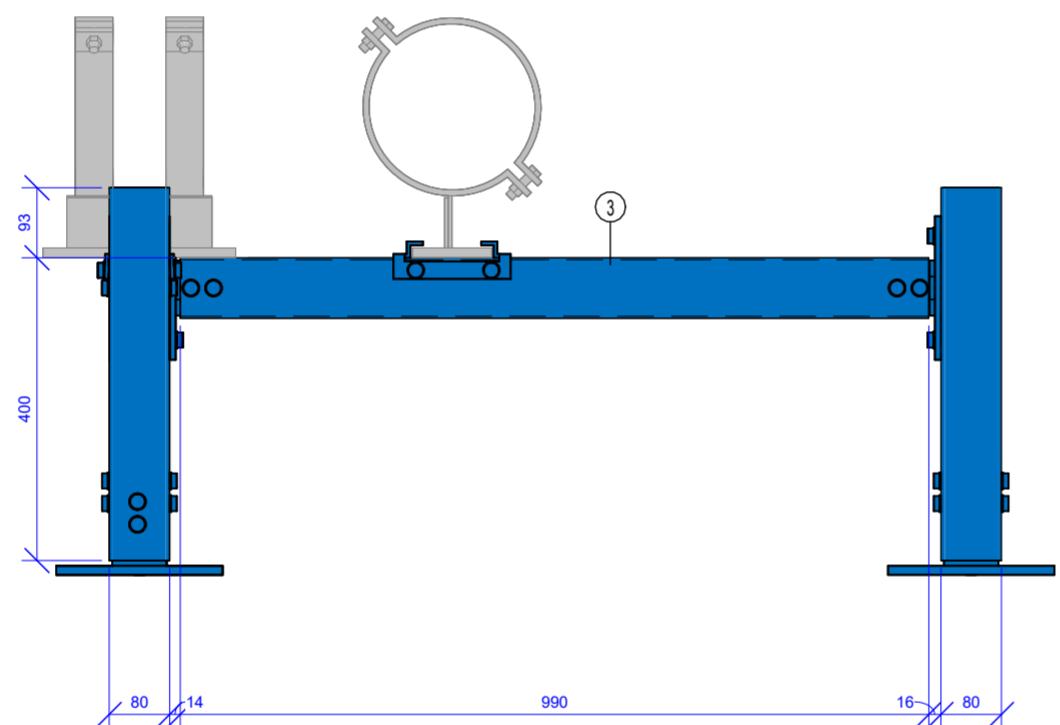

2 | Gantry Support 2.1.1 - Section B


SCALE: 1:10

Bill of Materials						
Pos	Type	QTY	Part No	Length	Weight	Total Weight
1	Beam Section TP F 80 6 m	3	192539	493 mm	3.16 kg	9.47 kg
2	Beam Section TP F 80 6 m	1	192539	493 mm	3.16 kg	3.16 kg
3	Beam Section TP F 80 6 m	1	192539	990 mm	6.34 kg	6.34 kg
4	End Support STA F 80 HCP	4	192856		1.60 kg	6.40 kg
5	End Support WBD F 80 80 120 HCP	3	192801		5.20 kg	15.60 kg
7	Self Forming Screw FLS F	44	192512		0.03 kg	1.32 kg

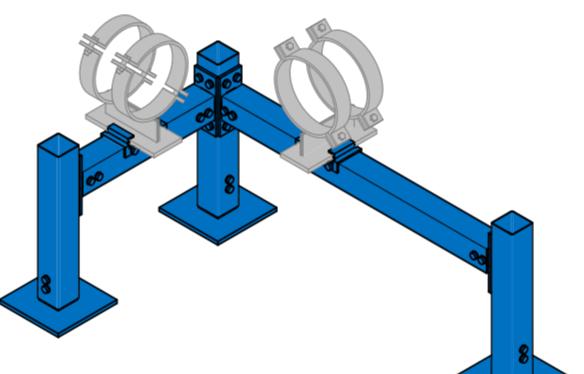

3 | Gantry Support 2.1.1 - 3D ISO

SCALE:

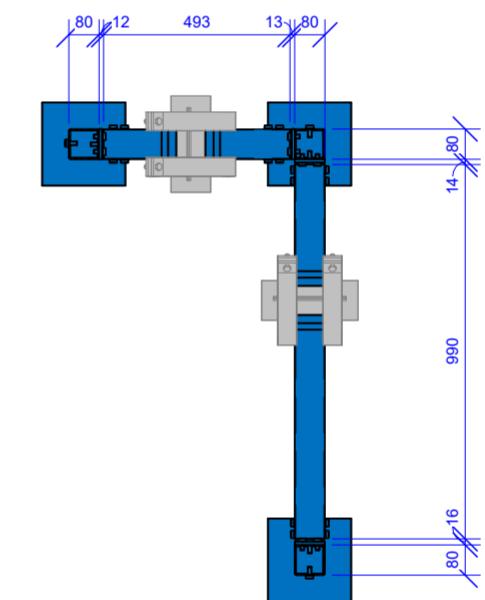

4 | Gantry Support 2.1.1 - Floor Plan

SCALE: 1:20

NOTE:

FORM2A Production:

Defines primary and secondary support component sizes, types and part numbers.

Scope Exclusion:

Frame interface with the building structure is not included in this document.

For comprehensive guidelines and additional information, contact the project management team.

OVERVIEW

MC Prefab is a collaborative joint venture between CTS, MECWIDE, and BIMMS. The primary objective of this partnership is to streamline the production of Mechanical, Electrical, and Plumbing (MEP) support structures.

To achieve standardization and optimization in support production, installation, and to minimize material waste, a comprehensive catalog of solutions has been developed. This catalog defines all support solutions along with their respective variables.

Process Stages:

The overall process of MEP support structure production and installation is divided into three distinct stages:

1-Preparation

2-Production

3-Installation

Each stage requires specific documentation, outlined as follows:

Form1A: Base Specification for Support Solution Definition

Form2A: Fabrication Drawing


Form3A: Installation Drawing

These documents ensure the standardization and efficiency of the entire process, from initial preparation through to final installation.

For any further details or clarifications, please refer to the MC Prefab documentation guidelines or contact the project management team.

Naming Convention

DC.FWA.COR.1.1-1A

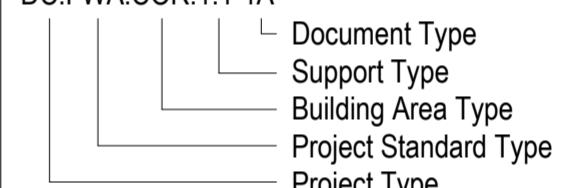

P02	03/12/2024	Issued For Information	GJ	JT
P01	08/11/2024	Issued For Information	GJ	JT
Rev.	Date	Description	Sign.	Veri.

JOINT VENTURE:

MC Prefab
Nordics

DESIGN & BUILD PARTNERS:

CTS Nordics

BIMMS
integrated engineering

MECWIDE
ENGINEERING CHALLENGES

DRAWING NAME:

DC.FWA.GAN.2.1.1-2A

DRAWING STATUS:	SCALE:	STATUS:
Issued For Information	S2	

DATE CREATED:	LAST REV. DATE:	SIGNED:	CONTROL:
08/11/2024	03/12/2024	GJ	JT

DRAWING NUMBER:	FORMAT:	REVISION:
FIN3005-BMS-XX-XX-DR-J-72112	A2	P02

